

SUPER STORM SANDY *Response and Recovery*

STATE OF CONNECTICUT DEPARTMENT OF HOUSING COMMUNITY DEVELOPMENT BLOCK GRANT DISASTER RECOVERY PROGRAM

OWNER OCCUPIED REHABILITATION AND REBUILDING PROGRAM (OORR)

GOVERNOR OF CONNECTICUT:
DANNEL P. MALLOY



COMMISSIONER OF HOUSING:
EVONNE M. KLEIN


APPLICATION NO. 2061

GRAY RESIDENCE
15 CAROLINE STREET
MILFORD, CONNECTICUT 06460

MARCH 24, 2015



ARCHITECT:

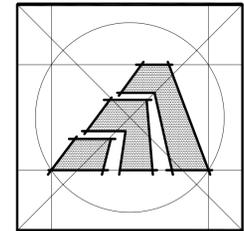


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GENERAL NOTES

- SCOPE OF WORK INCLUDES: ELEVATING EXISTING (1-1/2) STORY RESIDENCE FOR AN ADDITIONAL 26" +/- TO MEET THE (500-YEAR FLOOD ELEV.).
- THE WORK DESCRIBED IN THESE DOCUMENTS IS TO MEET HIGHEST QUALITY STANDARDS IN BOTH MATERIAL AND WORKMANSHIP. ANY SUBSTANDARD WORK WILL BE REJECTED.
- ALL WORK SHALL CONFORM TO THE MUNICIPALITY'S APPLICABLE BUILDING CODE, FIRE DEPT REGULATIONS, UTILITY COMPANY REQUIREMENTS, AND THE BEST TRADE PRACTICES.
- BEFORE COMMENCING WORK, THE CONTRACTOR SHALL FILE ALL REQUIRED CERTIFICATES OF INSURANCE WITH THE BUILDING DEPT, OBTAIN ALL REQUIRED PERMITS, AND PAY ALL FEES AS REQUIRED BY GOVERNING MUNICIPAL AGENCIES.
- THE CONTRACTOR SHALL VERIFY ALL DRAWING DIMENSIONS AND FIELD CONDITIONS, AND SHALL REPORT ANY DISCREPANCIES TO THE DESIGNER PRIOR TO COMMENCING WORK.
- MINOR DETAILS NOT USUALLY SHOWN OR SPECIFIED, BUT NECESSARY FOR PROPER CONSTRUCTION OF ANY PART OF THE WORK SHALL BE INCLUDED AS IF THEY WERE INDICATED IN THE DRAWING.
- THE CONTRACTOR SHALL COORDINATE ALL WORK PROCEDURES WITH THE REQUIREMENTS OF LOCAL AUTHORITIES.
- THE CONTRACTOR SHALL LAYOUT HIS OWN WORK, AND SHALL PROVIDE ALL DIMENSIONS REQUIRED FOR ALL OTHER TRADES (PLUMBING, ELECTRICAL, ETC.) IF APPLICABLE.
- PLUMBING AND ELECTRICAL WORK SHALL BE PERFORMED BY PERSONS LICENSED IN THEIR TRADES, WHO SHALL ARRANGE FOR AND OBTAIN INSPECTIONS AND REQUIRED SIGNING IF APPLICABLE.
- THE CONTRACTOR UPON COMPLETION OF JOB, SHALL APPLY FOR CERTIFICATE OF OCCUPANCY, AND SHALL ARRANGE FOR BUILDING DEPT INSPECTIONS AND SIGN-OFFS REQUIRED TO OBTAIN CERTIFICATE OF OCCUPANCY.
- MANUFACTURED ARTICLES ARE TO BE INSTALLED IN STRICT ACCORDANCE WITH THE MANUFACTURER'S SPECIFICATIONS IN ALL CASES. CONTRACTOR SHALL NOTIFY DESIGNER OF ANY CONDITIONS THAT IS IN CONFLICT WITH MANUFACTURER'S SPECIFICATIONS OR INSTRUCTIONS THAT MIGHT VOID A MANUFACTURER'S WARRANTY.
- THE CONTRACTOR SHALL ASSEMBLE IN A BINDER AND PASS ALONG TO THE OWNER ALL EQUIPMENT AND MATERIAL WARRANTIES THAT MAY EXTEND BEYOND THE BASE GUARANTEE PERIOD, AS WELL AS INSTALLATION AND MAINTENANCE INSTRUCTIONS IF APPLICABLE.
- NO SUBSTITUTIONS FOR MATERIALS SPECIFIED HEREIN SHALL BE PERMITTED WITHOUT PRIOR APPROVAL BY ARCHITECT.
- ARCHITECT AND ASSOCIATED CONSULTANTS DISCLAIMS ANY ACTUAL OR CONSEQUENTIAL DAMAGES ARISING FROM THIRD PARTY RELATIONSHIPS. THESE DRAWINGS DO NOT PROVIDE ALL OR ANY SPECIFIC DETAIL IN AREAS INCLUDING BUT NOT LIMITED TO NAILING, GLUING, CAULKING, FLASHING, PAINTING AND WATERPROOFING, OR CRAFTSMANSHIP. G.C. IS RESPONSIBLE TO PROVIDE PROPER SUPERVISED WORKMANSHIP.
- THE GENERAL CONTRACTOR SHALL BE RESPONSIBLE FOR "REINSTATING" THE SITE TO ORIGINAL CONDITIONS. (INCLUDING, BUT NOT LIMITED TO TOPSOIL, WALKWAYS, GRAVEL DRIVEWAYS AND BITUMINOUS PAVEMENT). STRIPPED TOPSOIL SHALL BE RE-SPREAD TO FINISH GRADE ELEVATION AND SEEDED.

ABBREVIATIONS

AC AIR CONDITIONING	L LENGTH
ACU AIR CONDITIONING UNIT	LAM LAMINATE
AFF ABOVE FINISHED FLOOR	LAV LAVATORY
AHU AIR HANDLING UNIT	LBL LABEL
ALUM ALUMINUM	LBS POUNDS
AND ANODIZED	LH LEFT HAND
AT ACOUSTICAL TILE	LN FT LINEAR FEET
BD BOARD	LT LIGHT
BLDG BUILDING	LTG LIGHTING
BO BY OTHERS	MAS MASONRY
CAB CABINET	MAX MAXIMUM
CD CEILING DIFFUSER	MECH MECHANICAL
CFM CUBIC FEET PER MINUTE	MFR MANUFACTURE(R)
< CENTER LINE	MIN MINIMUM
CLG CEILING	MISC MISCELLANEOUS
CLL CONTRACT LIMIT LINE	MM MILLIMETER
CMU CONCRETE MASONRY UNIT	MO MASONRY OPENING
COL COLUMN	MTD MOUNTED
CONC CONCRETE	MTL METAL
CONST CONSTRUCTION	MULL MULLION
CONT CONTINUOUS	MW MILLWORK
CPT CARPET(ED)	NA NOT APPLICABLE
CS COUNTER SINK	NC NOT IN CONTRACT
CT CERAMIC TILE	NO NUMBER
CTR COUNTER	NOM NOMINAL
CU FT CUBIC FEET	NTS NOT TO SCALE
CU IN CUBIC INCHES	OC ON CENTER
CW COLD WATER (CITY)	OD OUTSIDE DIAMETER
D DEPTH	OPNG OPENING
DEMO DEMOLITION	OPP OPPOSITE
DET DETAIL	PART PARTITION
DF DRINKING FOUNTAIN	PL PLATE
DHW DOMESTIC HOT WATER	PL LAM PLASTIC LAMINATE
DIAG DIAGONAL	PLB'G PLUMBING
DIAM DIAMETER	PLYWD PLYWOOD
DIM DIMENSION	PNL PANEL
DN DOWN	PNT PAINT
DR DOOR	PT POINT
DS DOOR STOP	QT QUARRY TILE
DW DISH WASHER	R RISE(R)
DWG DRAWING	RA RETURN AIR
DWR DRAWER	RAD RADIUS
EA EACH	RD ROOF DRAIN
EF EXHAUST FAN	REF REFERENCE
EH ELECTRIC HEATER	REINF REINFORCE
EL/ELEV. ELEVATION	REM REMOVE
ELEC ELECTRIC	REQD REQUIRED
EMER EMERGENCY	REV REVISION
ENG ENGINEER	RH RIGHT HAND
EP ELECTRIC PANEL	RM ROOM
EQ EQUAL	RO ROUGH OPENING
EQUIP EQUIPMENT	RP REVOLUTIONS PER MINUTE
EXIST'G EXISTING	SA SUPPLY AIR
EXP EXPANSION	SC SOLID CORE
EXT EXTERIOR	SHT SHEET
FACT FIN FACTORY FINISH	SIM SIMILAR
FBO FURNISHED BY OTHERS	SP SPEAKER
FE FIRE EXTINGUISHER	SPEC(S) SPECIFICATION(S)
FEC FIRE EXTINGUISHER CABINET	SQ SQUARE
FEE FINISH FLOOR ELEVATION	SQ FT SQUARE FOOT (FEET)
FIN FINISHED	SO IN SQUARE INCH
FL FLUORESCENT	SS STAINLESS STEEL
FOF FACE OF FINISH	ST STREET
FP FIRE PROOFING	STL STEEL
FPSC FIRE PROOF SOLID CORE	STD STANDARD
FR FIRE RESISTANT	SUSP SUSPENDED
FS FULL SCALE	SYM SYMMETRICAL
FTR FINNED TUBE RADIATION	SYS SYSTEM
GA GAUGE	T & G TONGUE & GROOVE
GC GENERAL CONTRACTOR	TEL TELEPHONE
GL GLASS	TEMP TEMPERATURE
GWB GYPSUM WALLBOARD	THERM THERMOSTAT
HC HOLLOW CORE	THK THICKNESS
HD HEAVY DUTY	THRU THROUGH
HDW HARDWARE	TOS TOP OF SLAB
HDWD HARDWOOD	TR TREAD
HM HOLLOW METAL	TST TOP OF STEEL
HOR HORIZONTAL	TV TELEVISION
HR HOUR	TYP TYPICAL
HT HEIGHT	UON UNLESS OTHERWISE NOTED
HTG HEATING	V VOLTS
HVAC HEATING, VENT, AIR COND.	VAC VACUUM
HWH HOT WATER HEATER	VCT VINYL COMPOSITE TILE
ID INSIDE DIAMETER	VERT VERTICAL
IN INCH	VIF VERIFY IN FIELD
INCL INCLUDE(ING)	W WIDTH
INFO INFORMATION	W/ WITH
INSUL INSULATION	W/O WITHOUT
INTR INTERIOR	WB WOOD BASE
INV INVERT	WC WATER CLOSET
IRC INTERNATIONAL RESIDENTIAL CODE	WO WOOD
J-BOX JUNCTION BOX	WP WATERPROOF
JT JOINT	WPT WORKING POINT
KO KNOCK OUT	WR WATER RESISTANT
KPL KICKPLATE	WT WEIGHT
	YD YARD

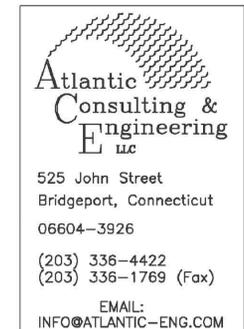LIST OF DRAWINGS

ARCHITECTURAL DRAWINGS	M.E.P. DRAWINGS
CS COVERSHEET	E-1 1st FLOOR ELECTRICAL PLAN
T-1 TITLE SHEET: GENERAL NOTES, DRAWING LIST, APPLICABLE CODES, SITE MAP, SYMBOL LEGEND, ETC.	
FE-1 EXISTING FOUNDATION PLAN	
AE-1 EXISTING 1st FLOOR PLAN	
F-1 FOUNDATION PLAN	
A-1 1st FLOOR PLAN	
A-2 FRONT AND REAR ELEVATIONS	
A-3 LEFT AND RIGHT ELEVATIONS	

LOCATION MAP



LEGEND

	GRAVEL
	CONCRETE
	MORTAR, GROUT
	STEEL
	FRAMING LUMBER
	HARDWOOD
	PLYWOOD
	BATT INSULATION
	GYPSUM WALLBOARD
	KEY NOTE
	DETAIL DRAWING NO.
	BUILDING SECTION
	WALL SECTION
	SECTION DETAIL
	COLUMN GRID
	PLAN / WALL DETAIL
	INTERIOR ELEVATION DRAWING NO.
	DATUM POINT (ELEVATION)
	DOOR NUMBER
	WINDOW NUMBER
	PARTITION TYPE
	REVISION FLAG
	REFERENCE KEY
	REMOVAL NOTE
	ROOM NUMBER
	EQUIPMENT TYPE
	CABINET TYPE
	C.O.D. CARBON MONOXIDE DETECTOR
	S.D. SMOKE DETECTOR (HARD WIRE)
	H.D. HEAT DETECTOR (HARD WIRE)
	CEILING FAN/LIGHT

BUILDING DESIGN DATA


GROUP R-3 FOR SINGLE FAMILY (1-1/2) STORY DWELLING	FLOOD ZONE - AE 11:
BUILDING CATEGORY: II	REQUIRED: DFE = 11.00' x 1.25 (500-YEAR FLOOD ELEVATION) + 1'-0" FREEBOARD = 14.75
CONSTRUCTION TYPE: V	PROPOSED: DFE = 14.75' (TOP OF FOUNDATION)
PROPOSED BUILDING MEAN HEIGHT 25'-0" +/-	PROPOSED: DFE = SEE SITE PLAN (TOP OF FINISH FLOOR)
WIND SPEED 100 MPH [PER IRC 2009 AND 2013 CT AMENDMENTS(AMD)]	DESIGNED FOR 500-YEAR FLOOD BASED ON SHPO & NFIP REGULATORY REQUIREMENTS:
WIND IMPORTANCE FACTOR - (Iw)=1.49 - PER TABLE R301.2(3)	FLOOD PLAIN MANAGEMENT REGULATIONS BY LOCAL JURISDICTION AND PER
WIND EXPOSURE - "C"	LATEST FIRM FLOOD MAPS & CONSENSUS STANDARDS
LAND USE ZONE - R5	

APPLICABLE CODES

APPLICABLE CODES: 2009 INTERNATIONAL RESIDENTIAL CODE AND CT 2013 AMENDMENTS.	
PER SECTION R301 DESIGN CRITERIA -	PER SECTION R313 - AUTOMATIC FIRE SPRINKLER SYSTEM -
R301.1 APPLICATION / MEETS REQUIREMENTS	R313.2 (AMD) - ONE AND TWO FAMIL DWELLINGS AUTOMATIC FIRE SPRINKLER SYSTEM / N/A (EXISTING)
R301.2 - CLIMATIC AND GEOGRAPHIC DESIGN CRITERIA / MEETS REQUIREMENTS	PER SECTION R314 - SMOKE ALARM:
R301.2.1 (AMD) - WIND LIMITATIONS / MEETS REQUIREMENTS	R314 - SMOKE ALARMS (PROVIDED)
TABLE R301.2.1(1) (AMD) - CLIMATIC AND GEOGRAPHIC DESIGN CRITERIA:	R314.4 (AMD) - POWER SOURCE (MEETS REQUIREMENTS)
(AMD) - GROUND SNOW LOAD - 30 LBS PSF / PROVIDED	PER SECTION R315 - CARBON MONOXIDE ALARM:
(AMD) - WIND SPEED (MPH) - 100 MPH PER APPENDIX R / MEETS REQUIREMENTS	R315.1 (AMD) - CARBON MONOXIDE ALARMS (TO BE PROVIDED)
(AMD) - SEISMIC DESIGN CATEGORY - CATEGORY B - (N/A)	PER SECTION R319 - SITE ADDRESS:
(AMD) - FLOOD HAZARD - AE	R319.1 - ADDRESS NUMBERS (MEETS REQUIREMENTS)
(AMD) - SUBJECT TO DAMAGE - FROST LINE DEPTH - 42 INCHES / EXISTING ENG. FOUNDATION	PER SECTION R322 - FLOOD-RESISTANT CONSTRUCTION:
R301.2(3) - HEIGHT AND EXPOSURE COEFFICIENTS FOR TABLE R301.2(2):	R322.1 - GENERAL (COMPLIES)
1.49 ADJUSTMENT PROVIDED	R322.1.2 - STRUCTURAL SYSTEM (PROVIDED)
R301.2.1.4 (AMD) - EXPOSURE CATEGORY / EXPOSURE C	R322.1.3 - FLOOD-RESISTANT CONSTRUCTION (MEETS REQUIREMENTS)
PER SECTION R302 - FIRE-RESISTANT CONSTRUCTION:	R322.1.4 - ESTABLISHING THE DESIGN FLOOD ELEVATION - 100-YEAR REQUIRED (AE 11' + 1'-0" FREEBOARD)
R302.1 (AMD) - EXTERIOR WALLS - MINIMUM FIRE SEPERATION / EXISTING WALLS - NO RATING REQUIRED	R322.1.4.1 - DETERMINATION OF THE DESIGN FLOOD ELEVATION (500-YEAR FLOOD PROVIDED PER DESIGN)
NEW DECKS AND STAIRS / MEET 5'-0" REQUIREMENTS - NO RATING REQUIRED	R322.1.5 - LOWEST FLOOR (EXCEEDS MIN. REQUIREMENTS)
PER SECTION R306 - SANITATION / MEETS REQUIREMENTS (BACKFLOW VALVE PROVIDED)	R322.1.6 - PROTECTION OF MECHANICAL AND ELECTRICAL (PROVIDED)
PER SECTION R311 - MEANS OF EGRESS -	R322.1.7 - PROTECTION OF WATER SUPPLY AND SANITARY SEWGE SYSTEMS (PROVIDED)
R311.1 - MEANS OF EGRESS / N/A (EXISTING)	R322.1.8 - FLOOD RESISTANT MATERIALS (PROVIDED)
R311.2 - EGRESS DOOR / N/A (EXISTING)	R322.1.10 - AS-BUILT ELEVATION DOCUMENTAION (PROVIDED)
PER SECTION R312 - GUARDS -	R322.2.1 - ELEVATION REQUIREMENTS (PROVIDED)
R312.1 - WHERE REQUIRED / PROVIDED	R322.2.3 - FOUNDATION DESIGN AND CONSTRUCTION (MEETS REQUIREMENTS)
R312.2 - HEIGHT / MEETS REQUIREMENTS	
R312.3 - OPENING LIMITATIONS / MEETS REQUIREMENTS	

PROJECT DATA

OWNER:	ZAZU GRAY 15 CAROLINE STREET MILFORD, CONNECTICUT 06460
SITE LOCATION:	15 CAROLINE STREET MILFORD, CONNECTICUT 06460

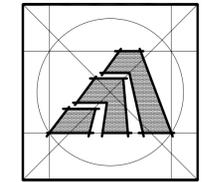

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Sheet Title:

TITLE SHEET

APPLICATION # 2061

GRAY RESIDENCE

15 Caroline Street
Milford, Connecticut 06460

STATE OF CONNECTICUT
DEPARTMENT OF HOUSING
COMMUNITY DEVELOPMENT BLOCK GRANT
DISASTER RECOVERY PROGRAM
 OWNER OCCUPIED REHABILITATION
 AND REBUILDING PROGRAM (OORR)


Date: 3/24/2015

Project Number: 2061

Drawn By: J.V.L.

Sheet Number:

T1

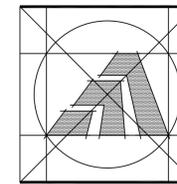

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Sheet Title:
EXIST. FOUND. PLAN



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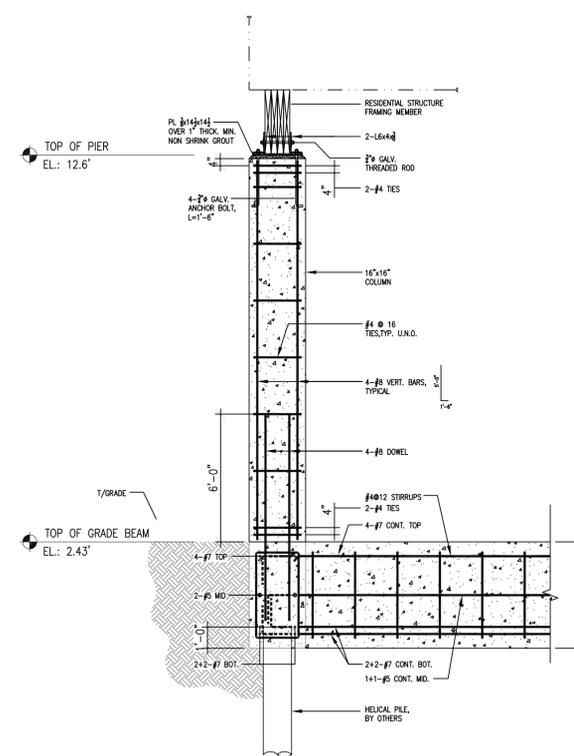
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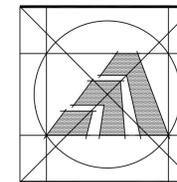
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FOUNDATION PLAN
SCALE: 1/4" = 1'-0"



FOUNDATION SECTION DETAIL
SCALE: 1/2" = 1'-0"



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Sheet Title:
Exist. 1st FLOOR PLAN

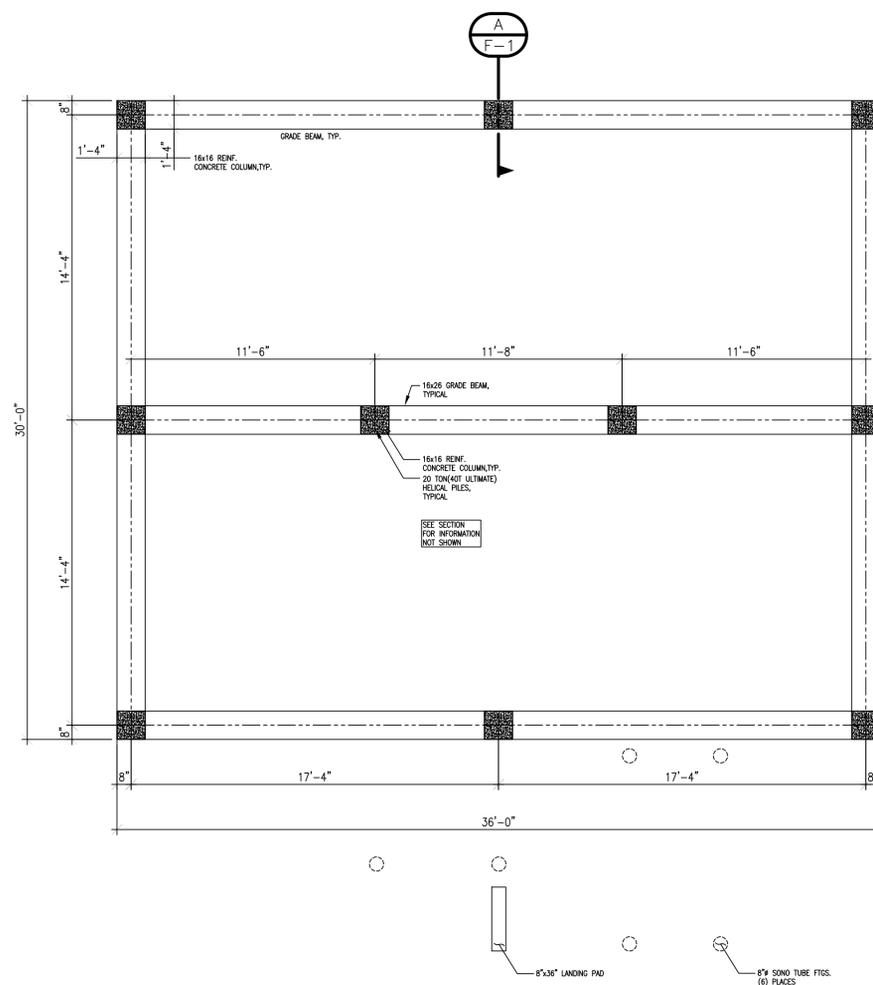
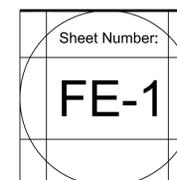
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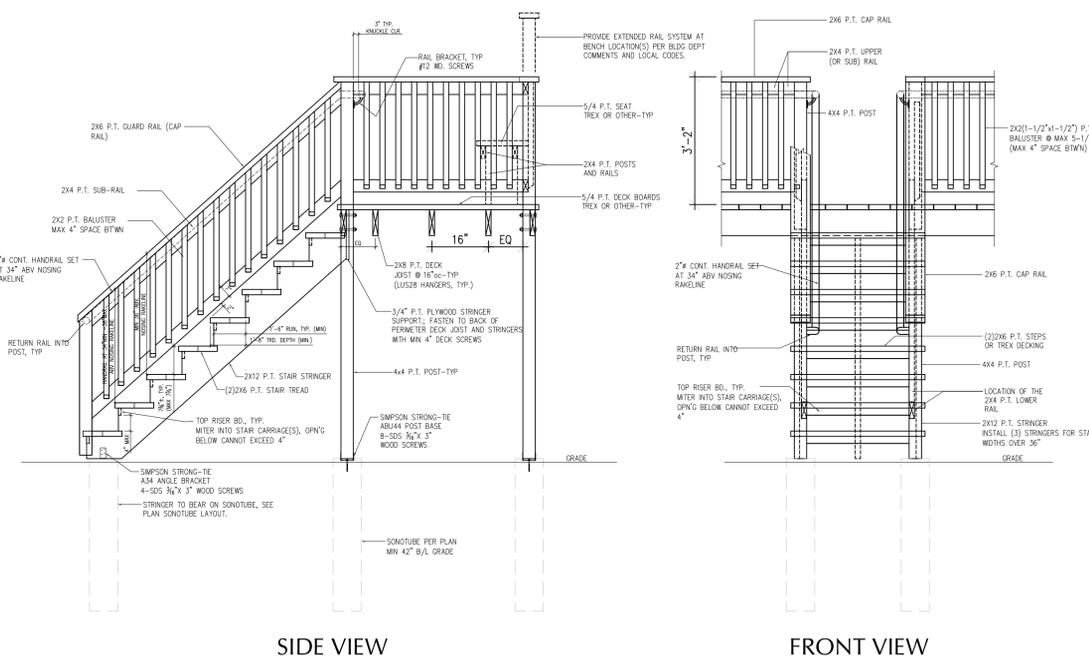
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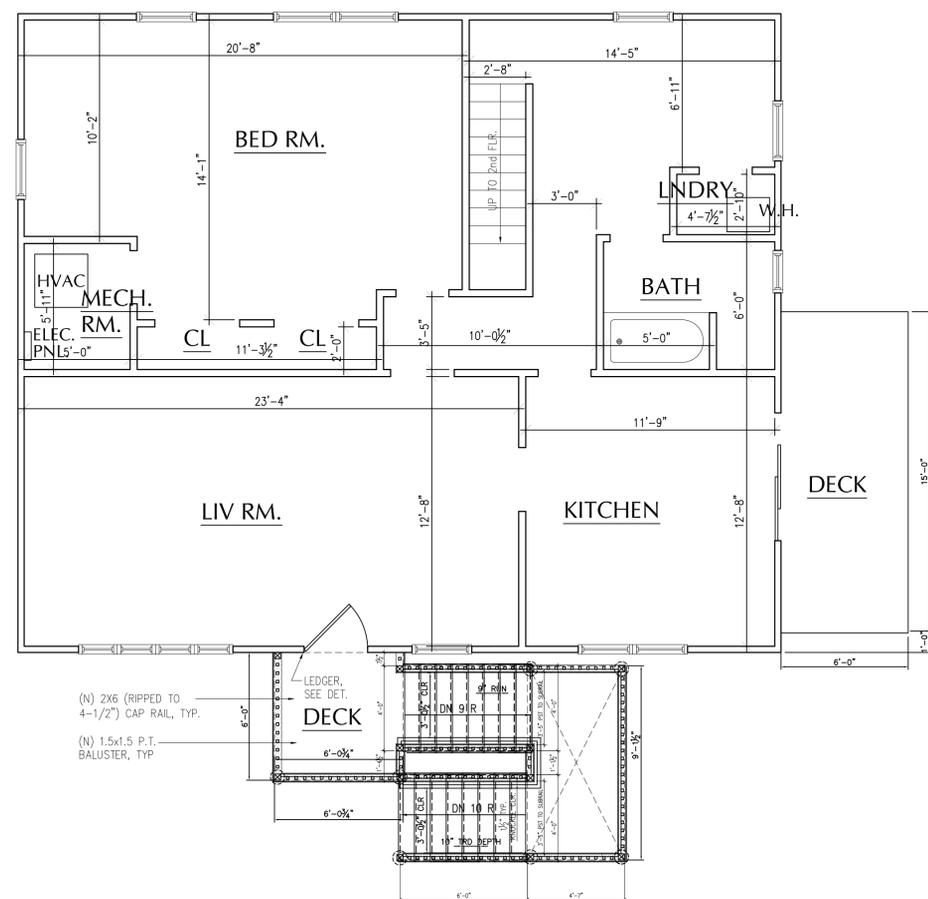
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POST / RAIL SECTION




TYP DECK/STAIR ASSEMBLY
SCALE: N.T.S.




NOTE:
1ST FLOOR IS ENTIRELY UNFINISHED AND DOWN TO BARE STUDS.

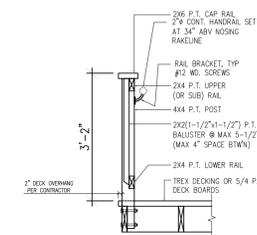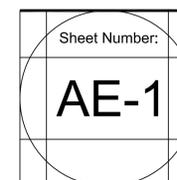1st FLOOR PLAN
SCALE: 1/4" = 1'-0"

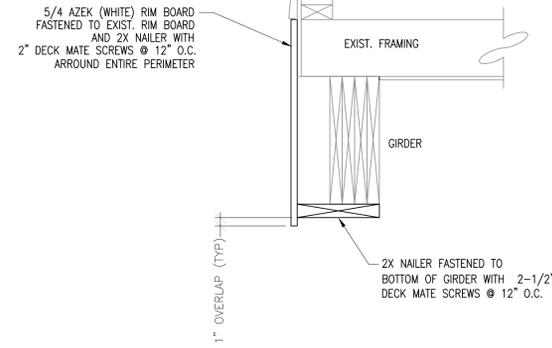


GIRDER COVER DETAIL

SCALE: 1/2" = 1'-0"

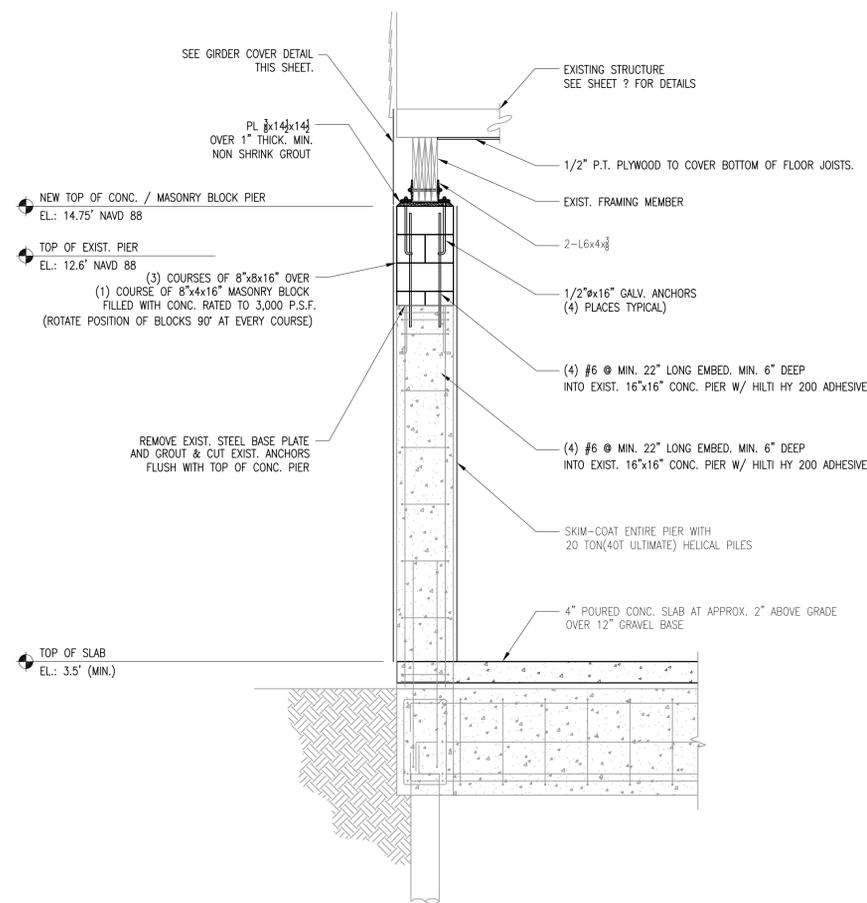

A **PIER DETAIL (Typical 10 Places)**

SCALE: 1/2" = 1'-0"

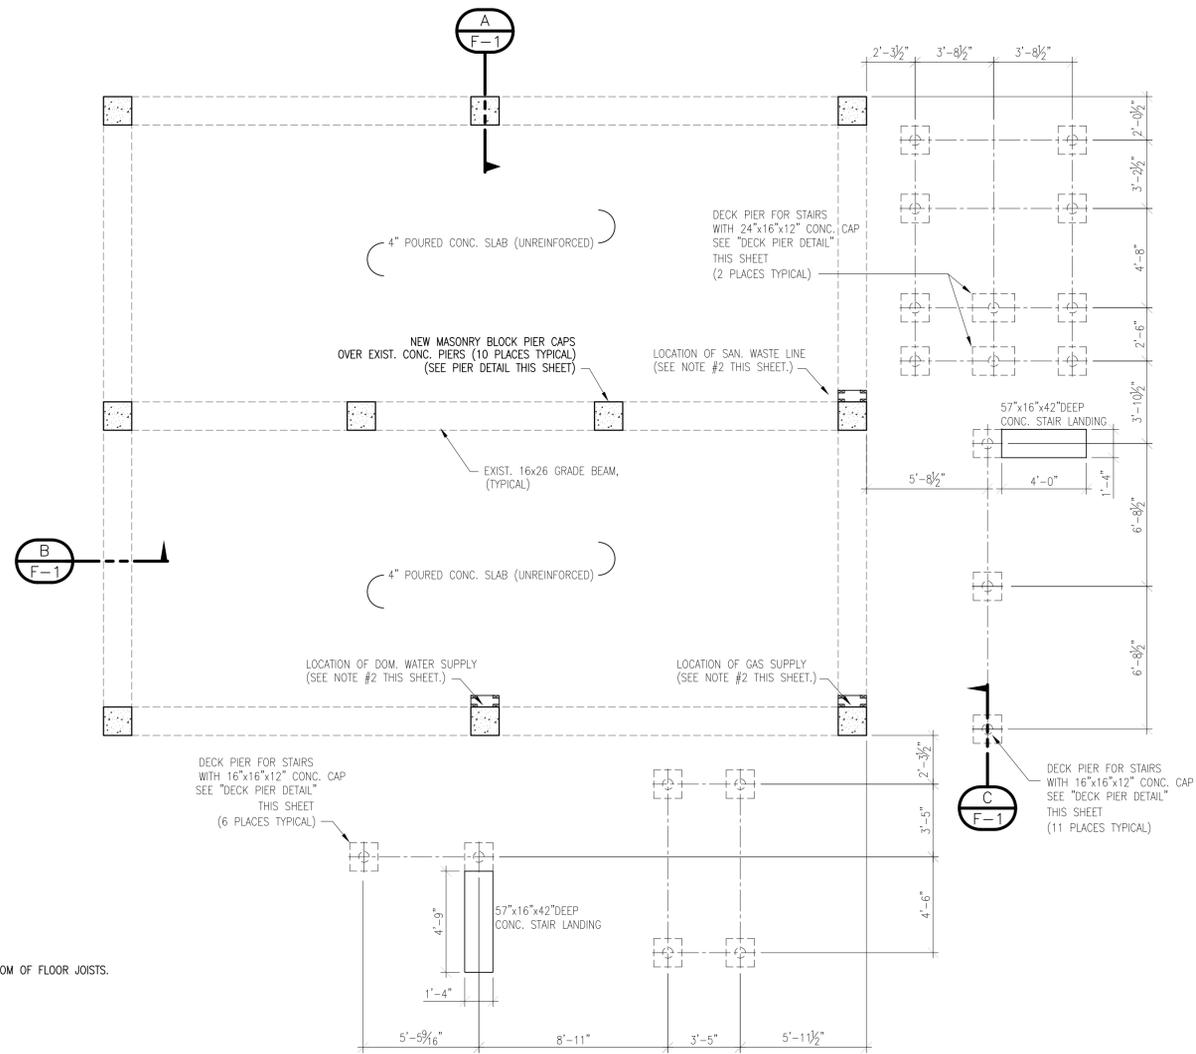


FOUNDATION PLAN

SCALE: 1/4" = 1'-0"


NOTES:

- 1.) REMOVE (6) EXIST. CONC. SONO TUBE AND STAIR LANDING DECK FOOTINGS PRIOR TO INSTALLING NEW DECK FOOTINGS.
- 2.) DOMESTIC WATER SUPPLY, GAS SUPPLY AND SANITARY WASTE LINES TO BE DISCONNECTED, REFIT TO ACCOMMODATE NEW ELEVATION OF HOUSE AND COVERED BY A WOOD FRAMED INSULATED CHASE WITH ACCESS TO ALL AREAS REQUIRED FOR TYPICAL MAINTENANCE.

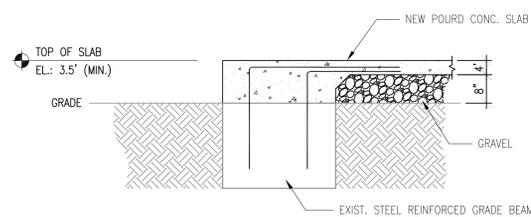


B **SLAB AT GRADE BEAM DETAIL**

SCALE: 1/2" = 1'-0"

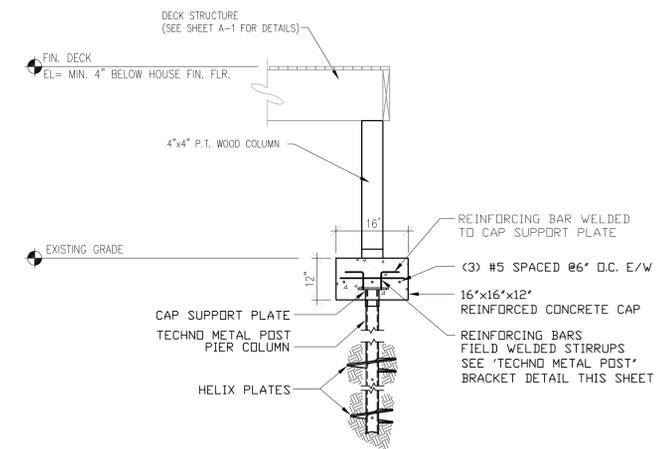

C **DECK PIER DETAIL**

SCALE: N.T.S.

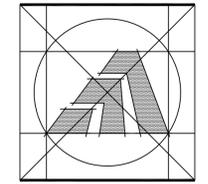

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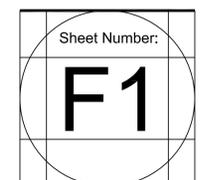
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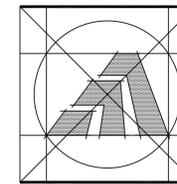
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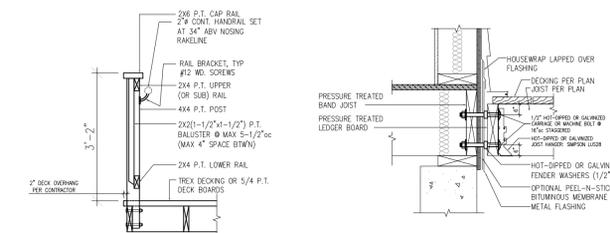
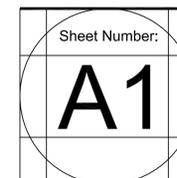
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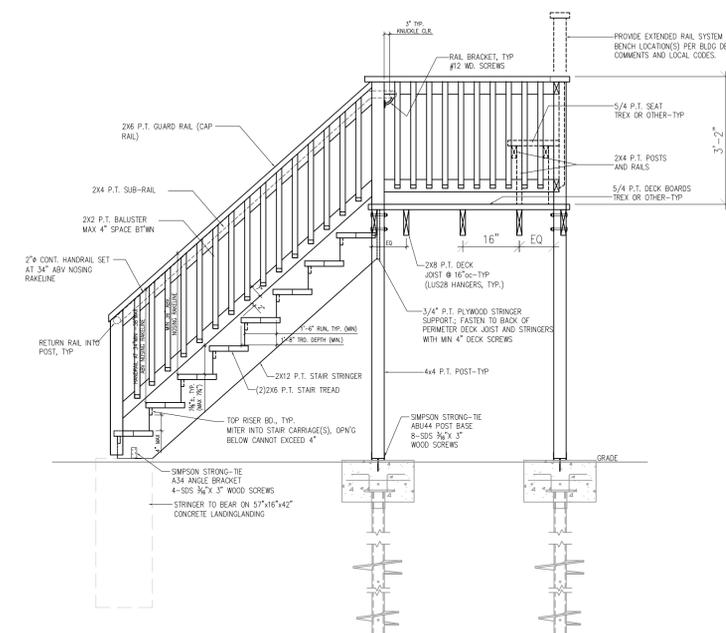
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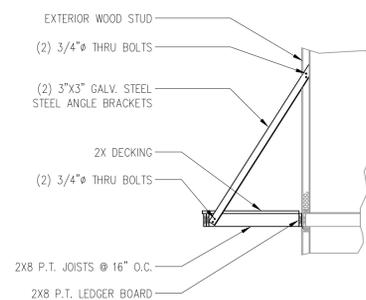
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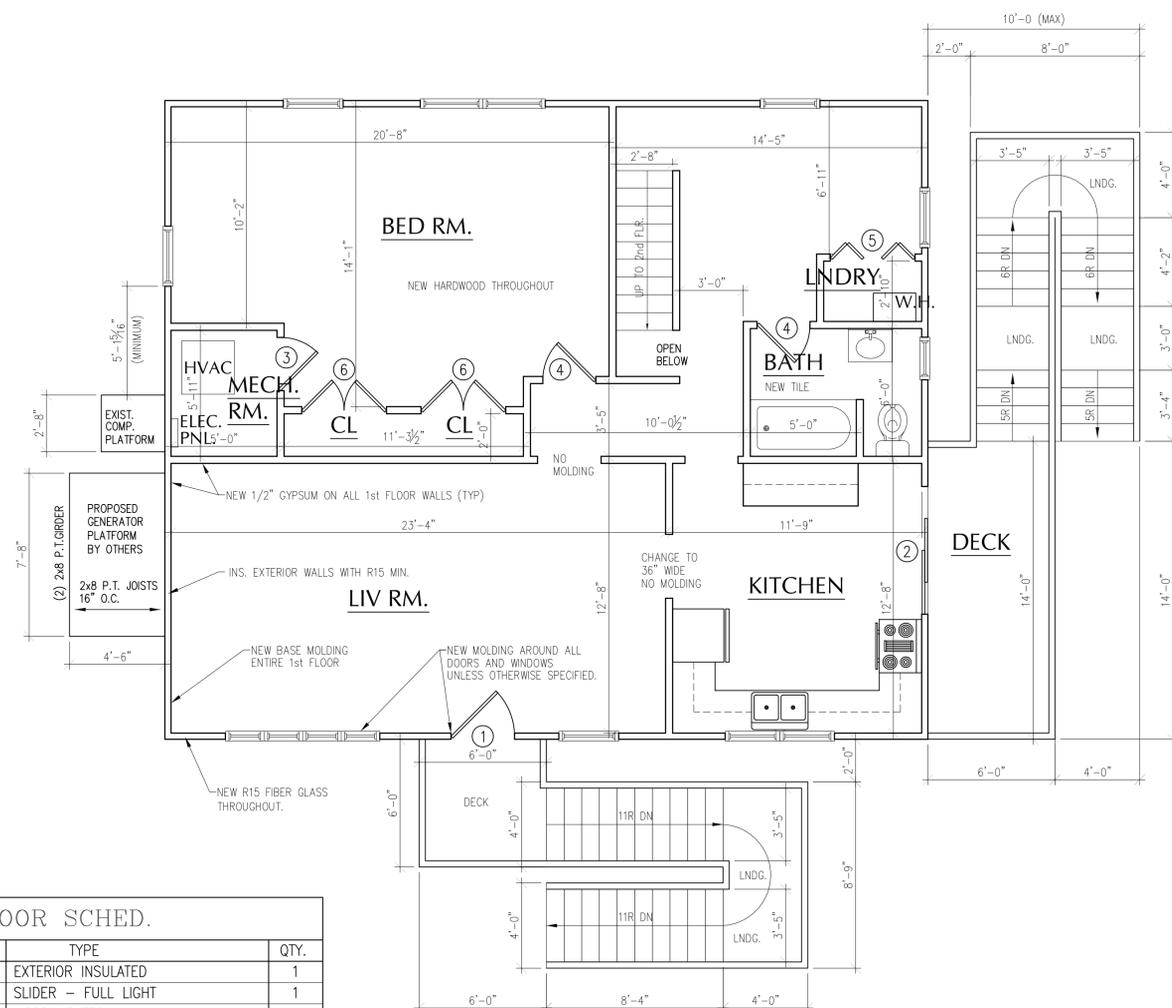
POST / RAIL SECTION LEDGER/ CONNECT. DETAIL



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SCALE: N.T.S.




GEN. PLATFORM SEC.
SCALE: 1/4" = 1'-0"



1st FLOOR PLAN

SCALE: 1/4" = 1'-0"

SYM		DOOR SCHED.	
I.D.	SIZE	TYPE	QTY.
1	3068	EXTERIOR INSULATED	1
2	6068	SLIDER - FULL LIGHT	1
3	2668	WOOD VENTED	1
4	2668	WOOD	2
5	4068	BI-FOLD WOOD	1
6	4068	DBL. HINGE WOOD	2

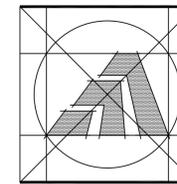

Amaya Architects
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Sheet Title:
FRONT & REAR ELEV.


APPLICATION # 2061

GRAY RESIDENCE
15 CAROLINE STREET
MILFORD, CT 06460

STATE OF CONNECTICUT
DEPARTMENT OF HOUSING
COMMUNITY DEVELOPMENT BLOCK GRANT
DISASTER RECOVERY PROGRAM
OWNER OCCUPIED REHABILITATION
AND REBUILDING PROGRAM (OORR)

Date: ISSUED 3/24/15

Drawn By: TJP

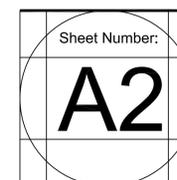

TOP OF RIDGE
EL.: 35.8' NAVD 88

18'-4 7/16"

TOP OF SUB FLOOR
EL.: 17.4' NAVD 88

2'-7 3/8"

TOP OF NEW MASONRY PIER
EL.: 14.75' NAVD 88

2'-2"


TOP OF EXIST. PIER
EL.: 12.6' NAVD 88

9'-6 1/16"


GRADE (L.A.G.)
EL.: 3.0' NAVD 88



WEST (Front) ELEVATION
SCALE: 1/4" = 1'-0"

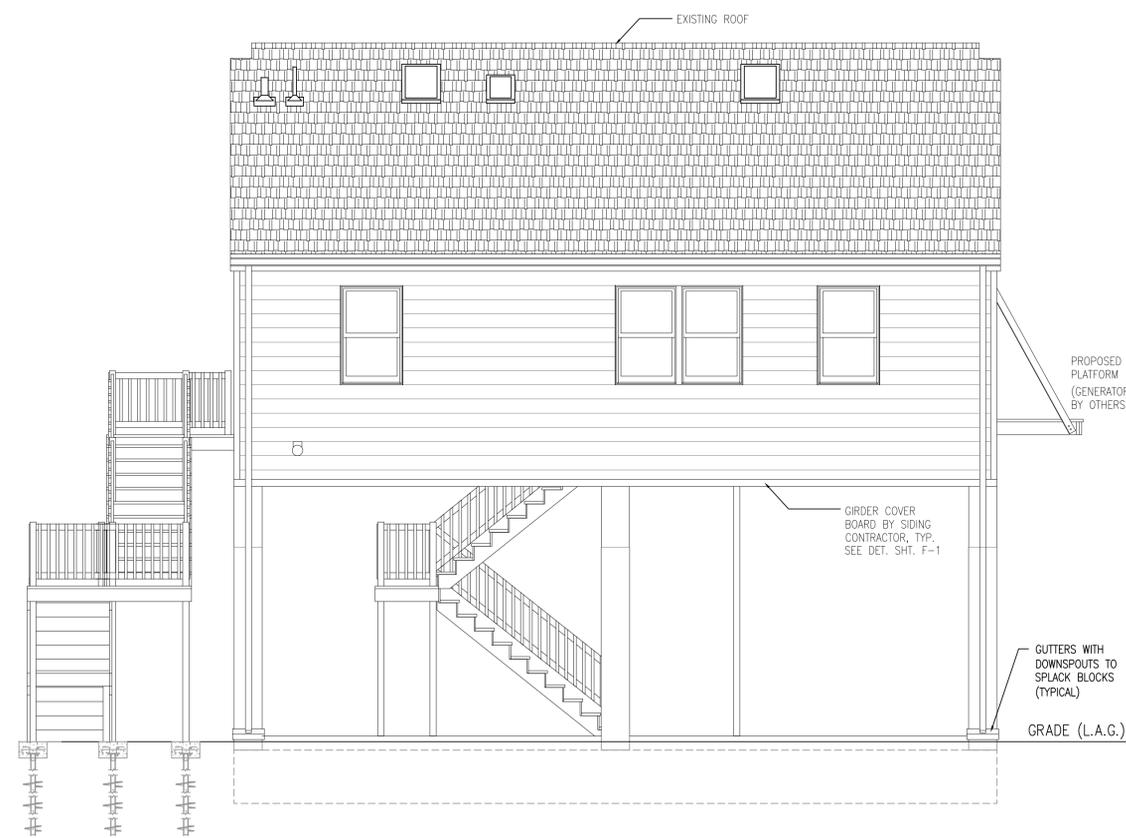

EAST (Rear) ELEVATION
SCALE: 1/4" = 1'-0"

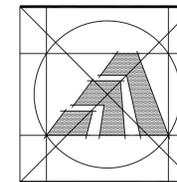

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Sheet Title:
LEFT & RIGHT ELEV.


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STATE OF CONNECTICUT
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TOP OF RIDGE
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18'-4 1/16"

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EL.: 17.4' NAVD 88

2'-7 3/8"


TOP OF NEW MASONRY PIER
EL.: 14.75' NAVD 88

2'-2"

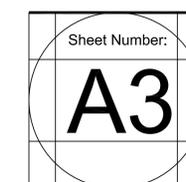
TOP OF EXIST. PIER
EL.: 12.6' NAVD 88

9'-6 3/16"

GRADE (L.A.G.)
EL.: 3.0' NAVD 88

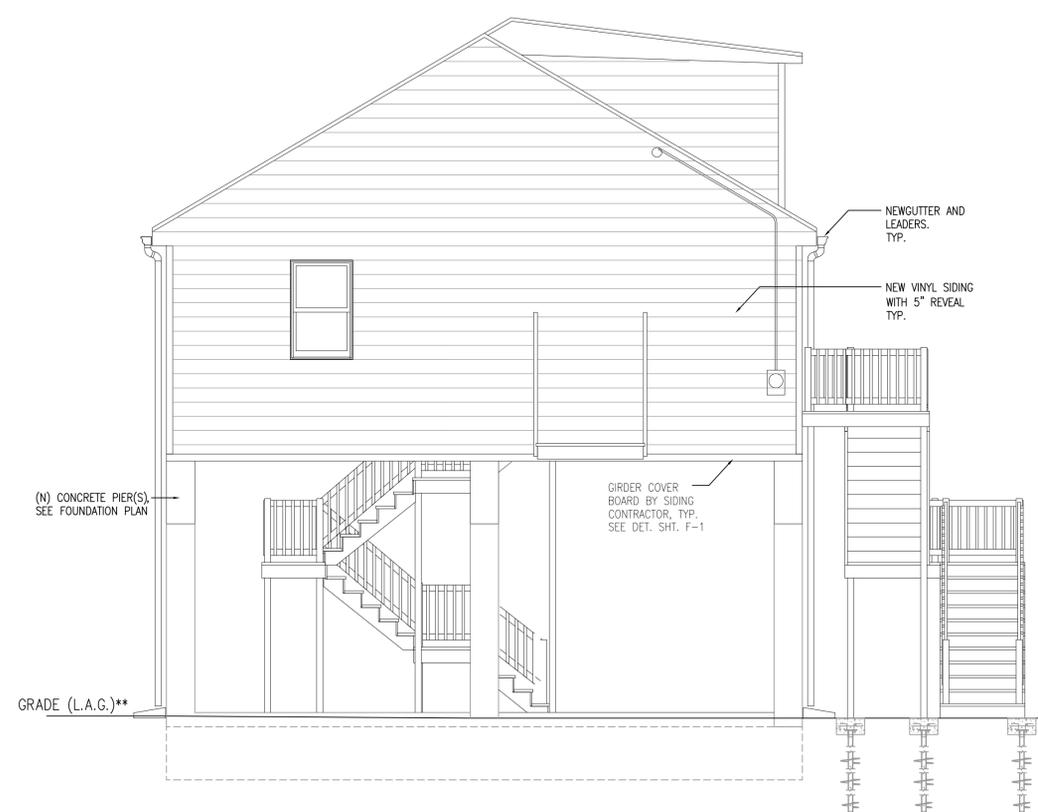

NORTH (Left Side) SIDE ELEVATION
SCALE: 1/4" = 1'-0"

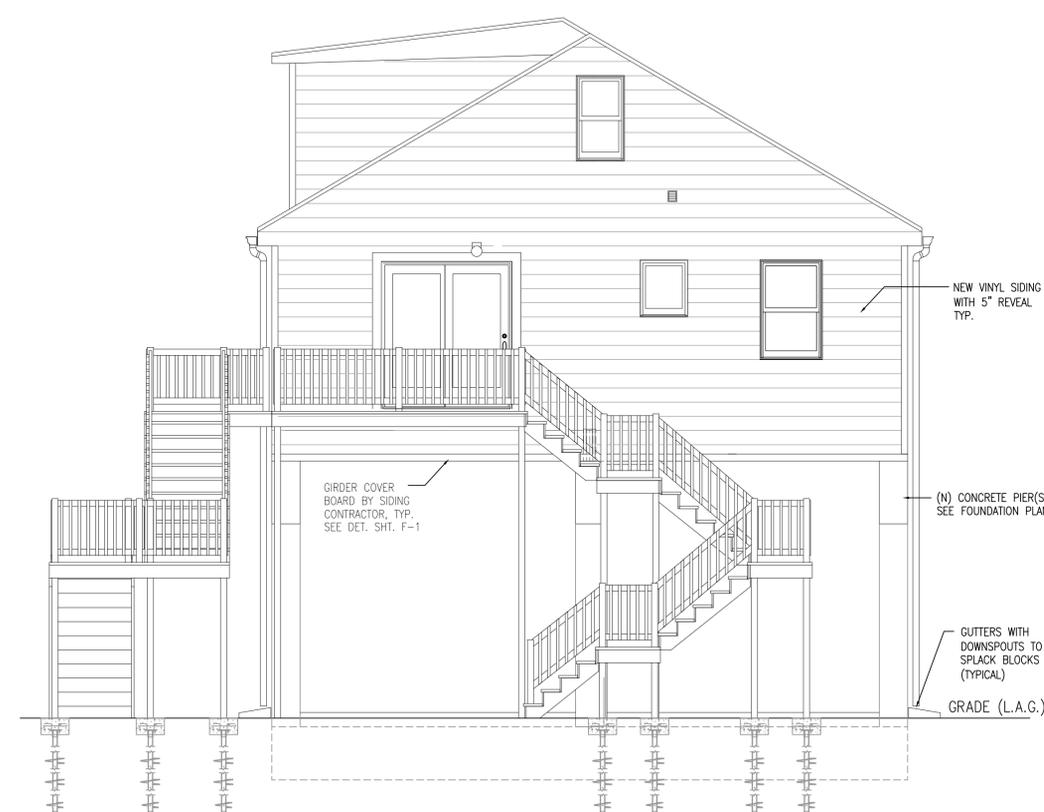


SOUTH (Right Side) SIDE ELEVATION
SCALE: 1/4" = 1'-0"

LEGEND:


S	SINGLE POLE SWITCH	☉	CEILING LIGHT WITH COVER
S ³	3-WAY SWITCH	⌘	WALL LIGHT W/COVER
⊕	DUPLEX RECEPTACLE	⊗	LIGHT AND EXHAUST FAN (2 SWITCH)
⊕ ^{AB}	DUPLEX RECEPTACLE ABOVE CABINERY	△	CABLE / COMMUNICATION
GFI	GROUND FAULT CIRCUIT INTERRUPT RECEPTACLE	☎	TELEPHONE SERVICE
WGFI	WEATHER PROOF GFI RECEPTACLE (EXT.)	⚡	SECURITY ALARM
⊖	THERMOSTAT	⊙	SMOKE DETECTOR
CS	CABLE SERVICE	⊙	CARBON MONOXIDE DETECTOR

NOTE:
ALL SWITCH AND RECEPTICAL COVERS MUST BE SUPPLIED.

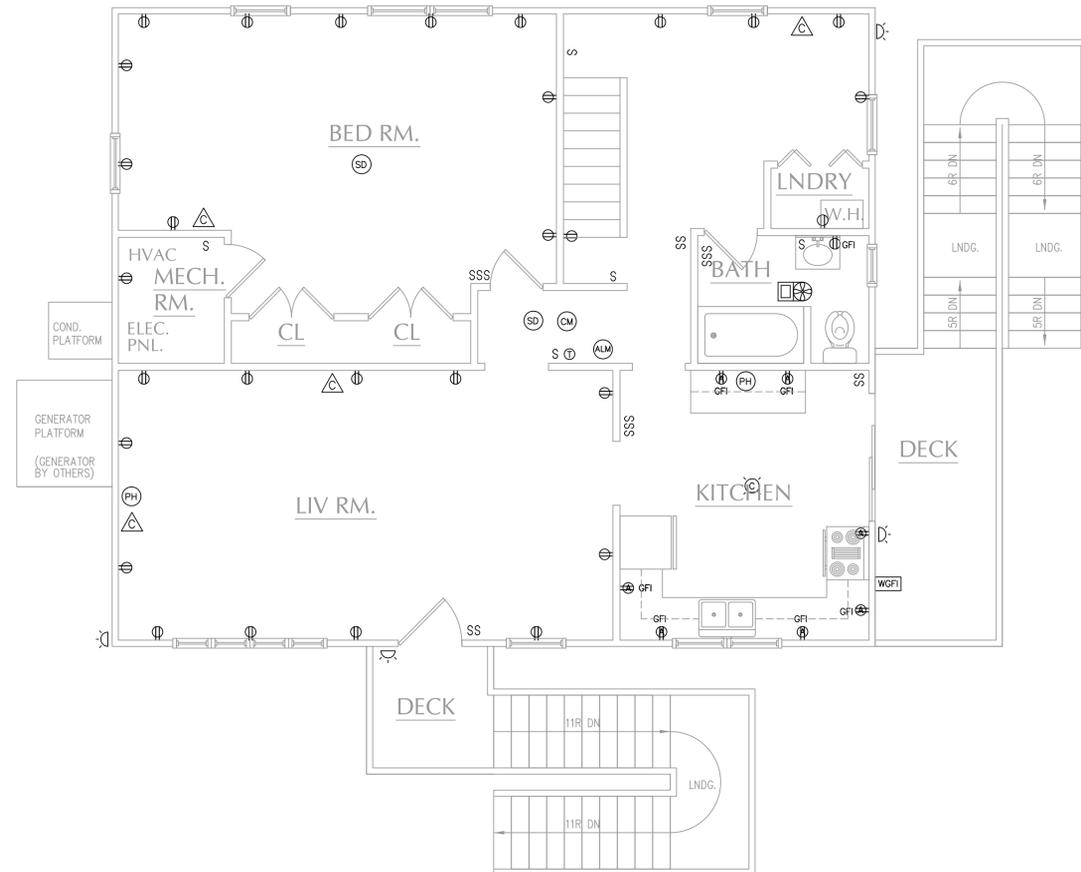

1st FLOOR ELECTRICAL PLAN

SCALE: 1/4" = 1'-0"

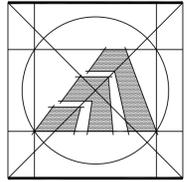

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Sheet Title:
1st FLOOR ELEC. PLAN

APPLICATION # 2061

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