



# QUISENBERRY ARCARI

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## ARCHITECTS, LLC

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REHABILITATION / RECONSTRUCTION WORK FOR:

# PAT MCINERNEY

APPLICANT #1493

ISSUE DATE: OCTOBER 13, 2014

528 LALLEY BOULEVARD

FAIRFIELD, CT

### LIST OF DRAWINGS


- COVER
- G1.0 GENERAL NOTES
- A1.1 BASEMENT & MAIN LEVEL FLOOR PLANS
- A1.2 UPPER LEVEL & ROOF PLANS
- A2.1 EXTERIOR ELEVATIONS

### COMMUNITY DEVELOPMENT BLOCK GRANT DISASTER RECOVERY PROGRAM (CDBG-DR)

### OWNER OCCUPIED REHABILITATION & REBUILDING PROGRAM (OORR)

SPONSORED IN CONJUNCTION WITH FUNDING FROM  
THE CONNECTICUT DEPARTMENT OF HOUSING

### LOCATION MAP

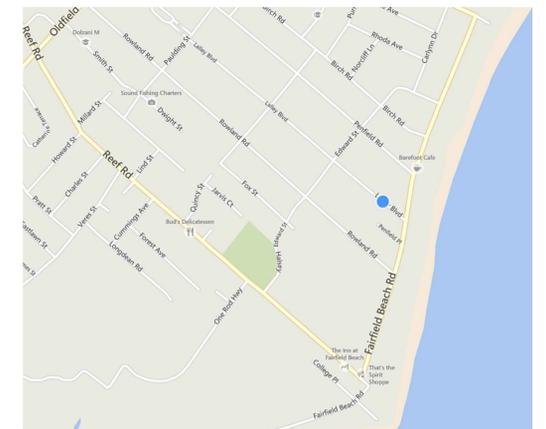

**ABBREVIATIONS**

A.F.F.	Above Finish Floor	HGT.	Height
A.C.	Acoustic, Acoustical	H.M.	Hollow Metal
A.C.T.	Acoustical Tile	HORIZ.	Horizontal
A/C	Air Conditioning	H.B.	Hose Bibb
A.H.U.	Air Handling Unit	IN.	Inch
ALT.	Alternate	INCL.	Included
ALUM.	Aluminum	INFO.	Information
ALF.	Aluminum Frame	I.D.	Inside Diameter
ANCH.	Anchor, Anchorage	INSUL.	Insulation
AB.	Anchor Bolt	INT.	Interior
L	Angle	JT.	Joint
ANOD.	Anodized	K.P.	Kick Plate
APPR.	Approved	LAB	Laboratory
ARCH.	Architect, Architectural	LAV.	Lavatory
ASB.	Asbestos	LTG.	Lighting
A.P.B.O.	As Provided By Owner	MACH.	Machine
A.S.B.O.	As Selected By Owner	MAINT.	Maintenance
ASPH.	Asphalt	MFRG.	Manufacturer
ASSY.	Assembly	M.BD.	Marker Board
ASST.	Assistant	MAS.	Masonry
AUTO.	Automatic	M.O.	Masonry Opening
BM	Beam	MAT.	Maternal
BRG.	Bearing	MAX.	Maximum
BEV.	Bevel, Beveled	MECH.	Mechanical
BIT.	Bituminous	MEZZ.	Mezzanine
BLK.	Block	MIN.	Minimum
BLKG.	Blocking	MISC.	Miscellaneous
BD.	Board	N	North
BOT.	Bottom	N.I.C.	Not In Contract
B.O.	Bottom Of	N.T.S.	Not To Scale
B.E.J.	Brick Expansion Joint	OFF.	Office
BLDG.	Building	O.C.	On Center
B.U.R.	Built Up Roofing	O.H.	Overhead
CAB.	Cabinet	O.D.	Outside Diameter
C.U.H.	Cabinet Unit Heater	PTD.	Painted
CAP.	Capacity	PR.	Pair
CASE	Casement	P.T.D.	Paper Towel Dispenser
CLG.	Ceiling	PASS.	Passage
CLGHT.	Ceiling Height	PERP.	Perpendicular
CEM.	Cement	PLAS.	Plaster
CTR.	Center	PLAM.	Plastic Laminate
CL	Centerline	PL.	Plate
C.T.	Ceramic Tile	PLUMB.	Plumbing
C.BD.	Chalk Board	PLYWD.	Plywood
CLO.	Closet	PVC.	Polyvinylchloride
COL.	Column	P.E.J.	Precast Expansion Joint
CONC.	Concrete	PREFAB.	Prefabricated
CONF.	Conference	QTY.	Quantity
CJ	Control Joint	Q.T.	Quarry Tile
CONT.	Continuous	RAD.	Radius
CONTR.	Contractor	RWC	Rain Water Conductor
CORR.	Corridor	RECV.	Receiving
CRS.	Course, Courses	REFR.	Refrigerator
DEG.	Degree	REINF.	Reinforce
DEMO.	Demolition	REM	Remove
DEPT.	Department	REQD	Required
DET.	Detail	REV.	Revised, Revision
DIA.	Diameter	R.	Riser
DIM.	Dimension	R.D.	Roof Drain
DIST.	Distance	RM.	Room
DR.	Door	S.N.D.	Sanitary Napkin Dispenser
DBL.	Double	S.N.R.	Sanitary Napkin Receptacle
D.H.	Double Hung	SCHED.	Schedule
DN	Down	SC.	Scupper
D.S.	Downspout	SECT.	Section
DWG.	Drawing	S.J.	Seismic Joint
D.F.	Drinking Fountain	SHT.	Sheet
EA.	Each	SIM.	Similar
ELEC.	Electric, Electrical	S.D.	Soap Dispenser
EWC.	Electric Water Cooler	S.T.D.	Sound Transmission Class
EL.	Elevation	S.T.C.	Sound Transmission Coefficient
ELEV.	Elevator	SPEC.	Specifications
EMERG.	Emergency	SQ.	Square
EQ.	Equal	S.F.	Square Feet
EQUIP.	Equipment	S.S.	Stainless Steel
EXIST.	Existing	STD.	Standard
E.T.R.	Existing To Remain	STL.	Steel
EXP.	Expansion	STOR.	Storage
E.J.	Expansion Joint	STRUCT.	Structure, Structural
EXT.	Exterior	S.STL.	Structural Steel
E.I.F.S.	Exterior Insulation Finish System	SUSP.	Suspend, Suspension
FT.	Feet, Foot	S.A.T.C.	Susp. Acoustic Tile Ceiling
F.R.G.P.	Fiber Reinforced Gypsum Panel	T.BD.	Tack Board
FIN.	Finish, Finished	THRU	Through
F.E.	Fire Extinguisher	T.P.D.	Toilet Paper Dispenser
F.R.	Fire Retardant	T.M.E.	To Match Existing
FPRFG.	Fireproofing	T&G	Tongue and Groove
FIXT.	Fixture	T.O.	Top Of
FLASH	Flashing	T.	Tread
FLR.	Floor	TYP.	Typical
F.D.	Floor Drain	U.L.	Underwriter's Laboratory
FLR.FIN.	Floor Finish	U.H.	Unit Heater
FTG.	Footing	U.V.	Unit Ventilator
FDN	Foundation	U.O.N.	Unless Otherwise Noted
FURN.	Furnish, Furnishings, Furniture	VEST.	Vestibule
FURR.	Furred, Furring	VCT.	Vinyl Composition Tile
GA.	Gauge	W.P.	Waterproofing
GALV.	Galvanized	W.W.F.	Welded Wire Fabric
GYP. BD.	Gypsum Board	W.BD.	White Board
G.C.	General Contractor	W	With
H.C.	Handicapped	WD.	Wood

**DESIGN CRITERIA**

GROUND SNOW LOAD	WIND DESIGN		SEISMIC DESIGN CATEGORY	SUBJECT TO DAMAGE FROM			WINTER DESIGN TEMP
	SPEED (mph)	TOPOGRAPHIC effects		Weathering	Frost Inc. depth	Tempts	
30 psf	100	r/a	B	SEVERE	42"	MODERATE TO HEAVY	7° F
ICE BARRIER UNDERLAYMENT REQUIRED	FLOOD HAZARD	AIR FREEZING INDEX	MEAN ANNUAL TEMP	CLIMATE ZONE			
YES	ZONE AE	1,500 OR LESS	50° F	5A			

2009 INTERNATIONAL RESIDENTIAL CODE W/ 2013 CONNECTICUT AMENDMENT  
 2009 INTERNATIONAL ENERGY CONSERVATION CODE W/ 2013 CONNECTICUT AMENDMENT  
 2011 NATIONAL ELECTRICAL CODE (NFPA 70) W/ 2013 CONNECTICUT AMENDMENT

**ARCHITECTURAL SYMBOLS**

	EXISTING WALL
	WALL TO BE DEMOLISHED
	NEW STUD WALL
	NEW CMU WALL
	NEW FOUNDATION WALL
	ROOM NAME FLOOR FINISH ROOM SIZE (if applicable)
	SECTION MARKER
	ELEVATION MARKER
	WINDOW IDENTIFICATION
	ELEVATION MARKER
	EXISTING DOOR
	NEW DOOR

**GENERAL NOTES**


- ALL CONSTRUCTION ON THIS HOME, AND ANY CHANGES MADE TO THE DESIGN OF THIS HOME, EITHER BEFORE OR DURING CONSTRUCTION SHALL BE DONE IN ACCORDANCE WITH THE BUILDING CODE. NOTHING REPRESENTED WITHIN THESE PLANS SHALL ALLEVIATE THE APPLICABLE CODE REQUIREMENTS FOR THE CONSTRUCTION RELATED TO THIS PROJECT.
- NOTIFY QUISENBERRY ARCARI ARCHITECTS, LLC AT (860) 677-4594 IMMEDIATELY IF PROBLEMS SHOULD ARISE DURING THE CONSTRUCTION ON THIS HOME WITH RESPECT TO STRUCTURAL INTEGRITY, FRAMING CONFLICTS, OR GENERAL CONCERNS.
- THESE DRAWINGS DO NOT REPRESENT ALL COMPONENTS OR DETAILS REQUIRED TO PROPERLY CONSTRUCT THIS HOME. IT IS ASSUMED THAT THE WORK WILL BE PERFORMED BY COMPETENT, SKILLED AND LICENSED TRADE CONTRACTORS IN ACCORDANCE WITH INDUSTRY STANDARDS AND CARE.
- UNLESS OTHERWISE NOTED ON THE DRAWINGS, ALL NEW FINISHES (ROOFING, SIDING, TRIM, ETC.) SHALL MATCH EXISTING.
- PATCH EXISTING AREAS AFFECTED BY THE NEW WORK. MATCH EXISTING FINISHES UNLESS DIRECTED OTHERWISE BY THE OWNER.
- EXTEND EXISTING SERVICES (MECHANICAL, PLUMBING, ELECTRICAL, ETC.) TO ACCOMMODATE THE NEW CONSTRUCTION. PROVIDE UPGRADES TO EXISTING COMPONENTS AS NECESSARY TO PROVIDE SATISFACTORY PERFORMANCE WITHIN THE COMPLETED STRUCTURE.

**CONCRETE MASONRY**

- ALL MASONRY SHALL CONFORM TO AND BE ERRECTED IN ACCORDANCE WITH ACI 530 BUILDING CODE REQUIREMENTS FOR MASONRY STRUCTURES AND ACI 530.1 SPECIFICATION FOR MASONRY STRUCTURES.
- ALL MASONRY WALLS ARE TO BE CONSTRUCTED OF CONCRETE MASONRY WITH COMPRESSIVE STRENGTH FM = 1500 P.S.I. THE CONTRACTOR IS RESPONSIBLE FOR ASSURING MASONRY STRENGTH AS SPECIFIED.
- TYPE "M" OR "S" MORTAR SHALL BE USED IN ALL MASONRY.
- CONTINUOUS HORIZONTAL JOINT REINFORCING SHALL BE INSTALLED IN ALTERNATE COURSES OF ALL MASONRY. EXTERIOR MASONRY VENER SHALL BE TIED TO INTERIOR MASONRY BLOCKWORK IN ACCORDANCE WITH DRAWING NOTATIONS.
- REINFORCING STEEL FOR MASONRY SHALL BE GRADE 60. ALL LAP SPLICES SHALL BE A MINIMUM OF 48 BAR DIAMETERS (I.E. #4 BAR = 24").
- ALL MASONRY UNIT CORES CONTAINING REINFORCING BARS SHALL BE FILLED WITH 2000 P.S.I. GROUT. GROUT SHALL BE INSTALLED IN USING LOW LIFT GROUT METHOD (5'-0" MAXIMUM LIFTS).

**FINISHES**

- GYPSSUM BOARD**
- PROVIDE AND INSTALL GYPSSUM WALL BOARD IN ACCORDANCE WITH AMERICAN STANDARD SPECIFICATIONS FOR THE APPLICATION AND FINISHING OF GYPSSUM WALLBOARD, AS APPROVED BY THE AMERICAN STANDARDS ASSOCIATION, LATEST EDITION; APPLICABLE PARTS THEREOF ARE HEREBY MADE A PART OF THIS SPECIFICATION EXCEPT WHERE MORE STRINGENT REQUIREMENTS ARE CALLED FOR IN THE SPECIFICATION, IN LOCAL CODES, OR BY THE MANUFACTURER OF THE GYPSSUM WALLBOARD, WHOSE REQUIREMENTS SHALL BE FOLLOWED.
  - PROVIDE AND INSTALL MOISTURE-RESISTANT GYPSSUM WALLBOARD WHERE REQUIRED. PROVIDE TYPE X GYPSSUM BOARD AS CALLED FOR ON THE DRAWINGS.
  - PROVIDE 1/2" TYPE X GYPSSUM BOARD AT ALL WALLS BETWEEN GARAGE AND HOUSE. 5/8" TYPE X GYPSSUM BOARD SHALL BE PROVIDED AT GARAGE CEILING WHICH HAS LIVING SPACE ABOVE.
- PAINT**
- APPLICATION OF PAINT OR OTHER COATING SHALL BE IN STRICT ACCORDANCE WITH MANUFACTURER'S INSTRUCTIONS. READY-MIXED PAINT SHALL NOT BE THINNED, EXCEPT AS PERMITTED IN THE APPLICATION INSTRUCTIONS.

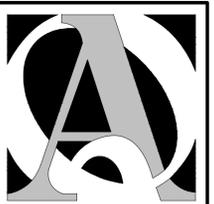

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528 LALLEY BOULEVARD  
 FAIRFIELD, CT

Sheet Description:

**GENERAL NOTES**

**Issue Dates:**  
 ISSUED FOR BID:  
 OCTOBER 13, 2014

**No Scale**

**Project #:** QA 1346-22  
**Drawn By:** CJO

**Sheet #:**

**G1.1**



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528 LALLEY BOULEVARD FAIRFIELD, CT

Sheet Description:

**BASEMENT & MAIN LEVEL FLOOR PLAN**

Issue Dates:


ISSUED FOR BID:  
OCTOBER 13, 2014

Scale: 1/4" = 1'-0"

Project #: QA 1346-22 Drawn By: CJO

Sheet #:


**A1.1**

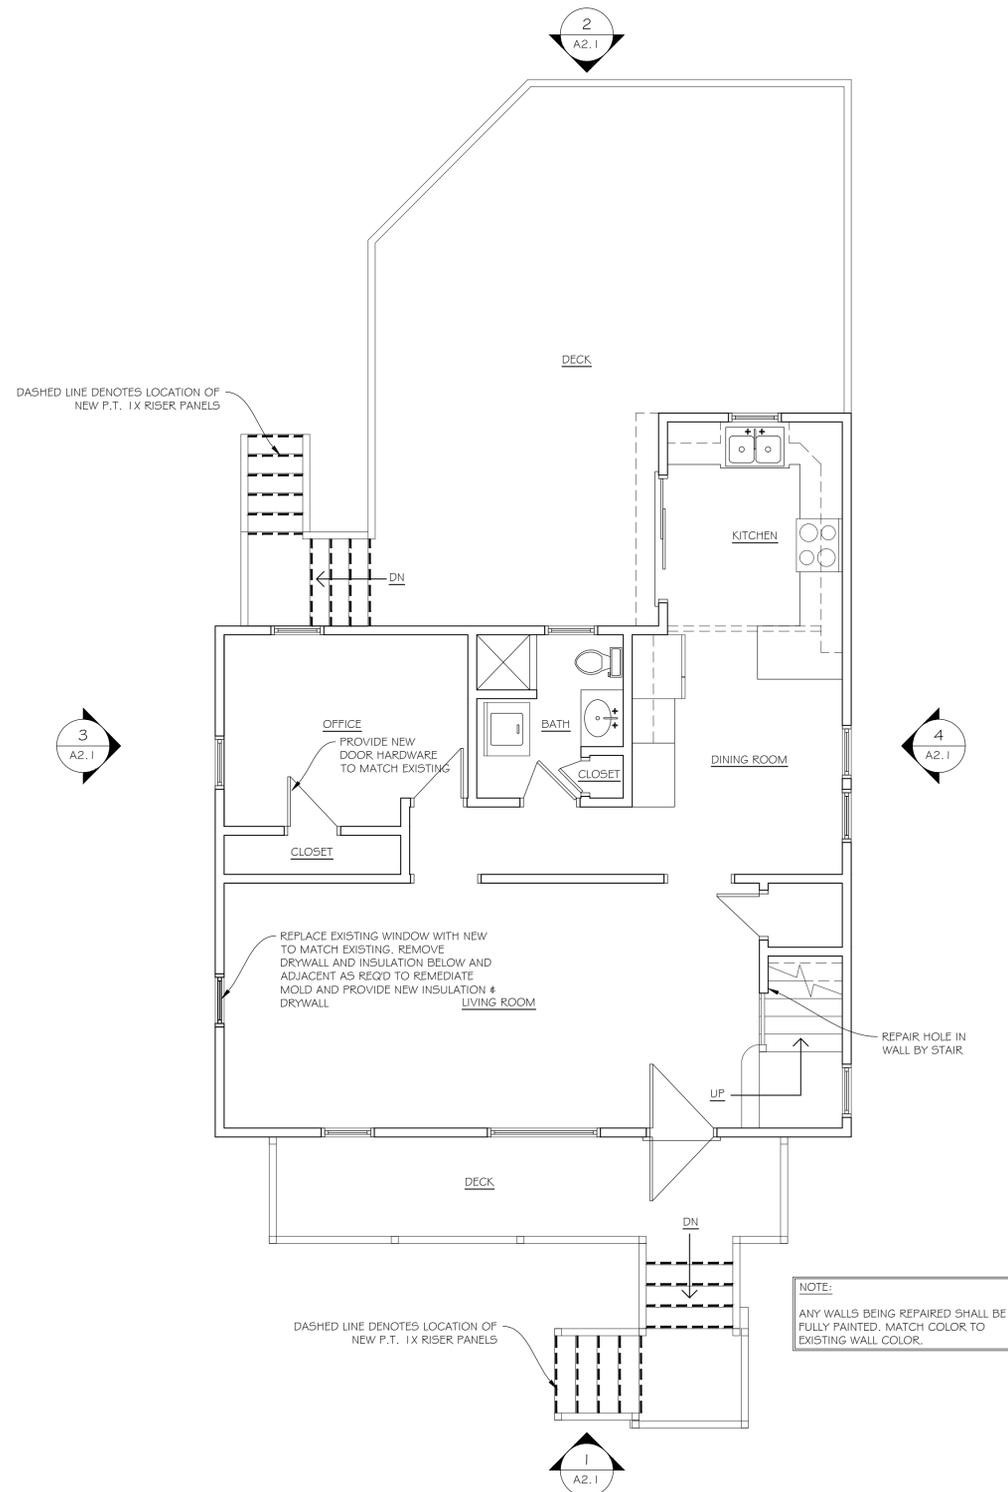

**MAIN LEVEL FLOOR PLAN**

SCALE: 1/4" = 1'-0"

2

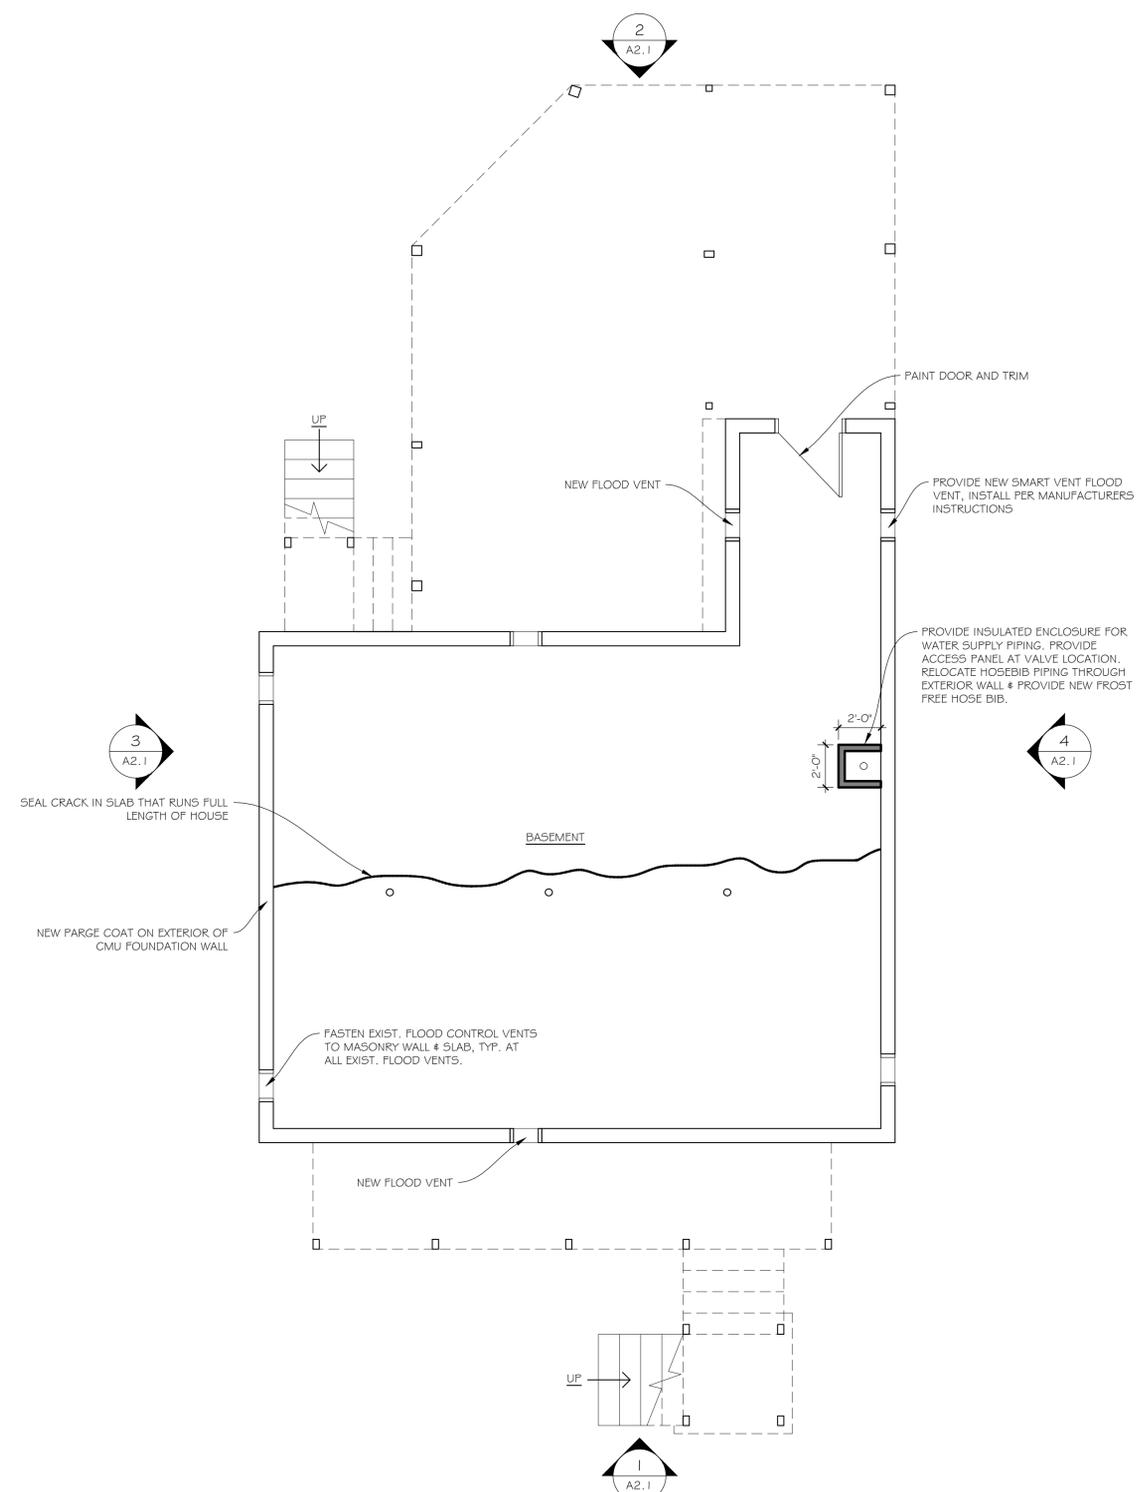

**FOUNDATION/BASEMENT PLAN**

SCALE: 1/4" = 1'-0"

1



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Sheet Description:

UPPER LEVEL &  
ROOF PLANS  
& MISC.  
DETAILS

Issue Dates:


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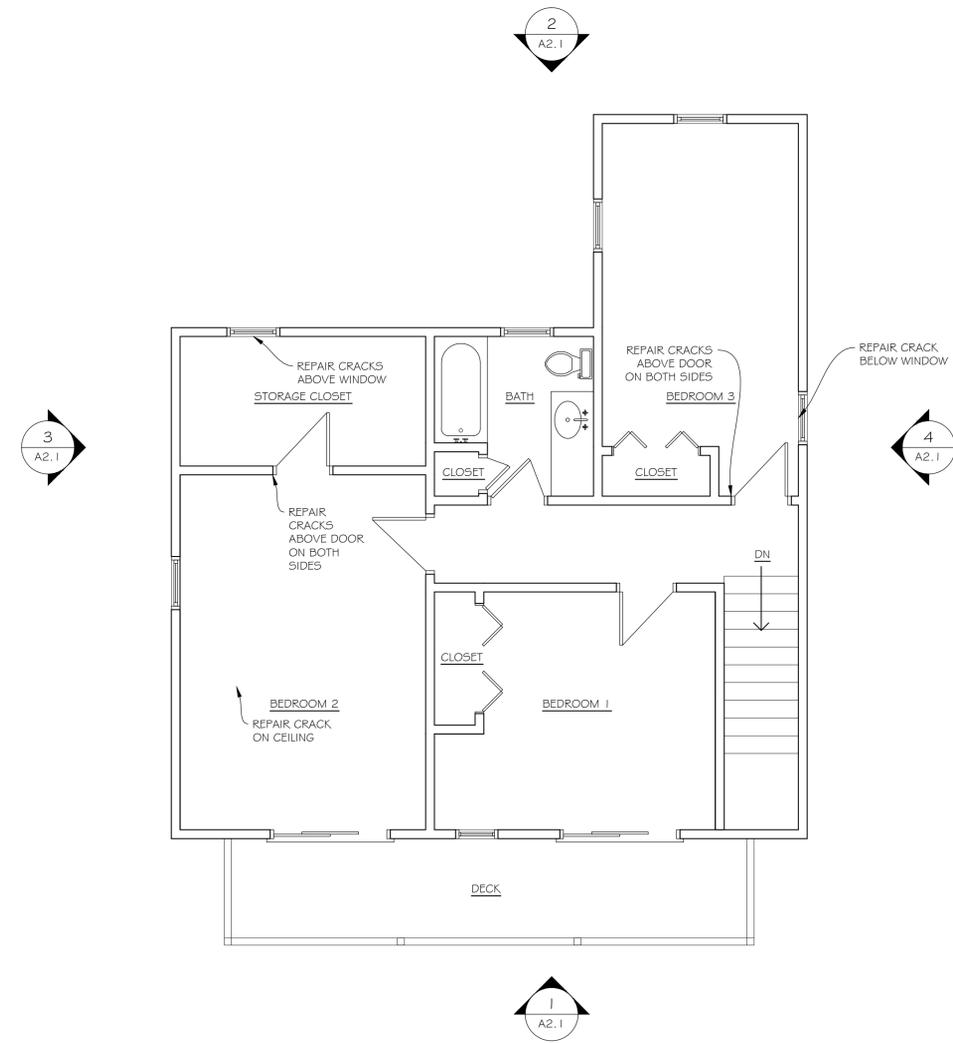
**A1.2**



**ROOF PLAN**

SCALE: 1/4" = 1'-0"

2

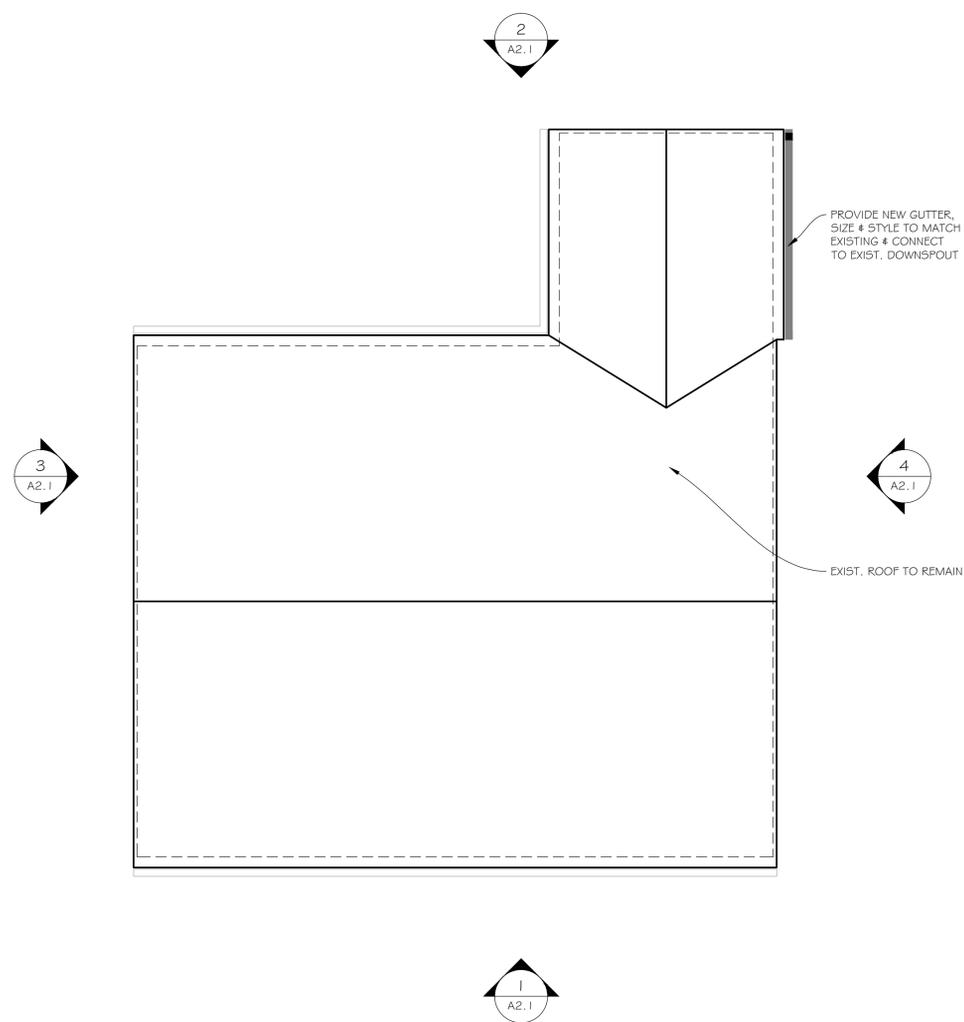

**UPPER LEVEL FLOOR PLAN**

SCALE: 1/4" = 1'-0"

1



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Sheet Description:

**EXTERIOR ELEVATIONS**

Issue Dates:


ISSUED FOR BID:  
 OCTOBER 13, 2014

Scale: 1/4" = 1'-0"

Project #: QA 1346-22  
 Drawn By: CJO

Sheet #:

**A2.1**

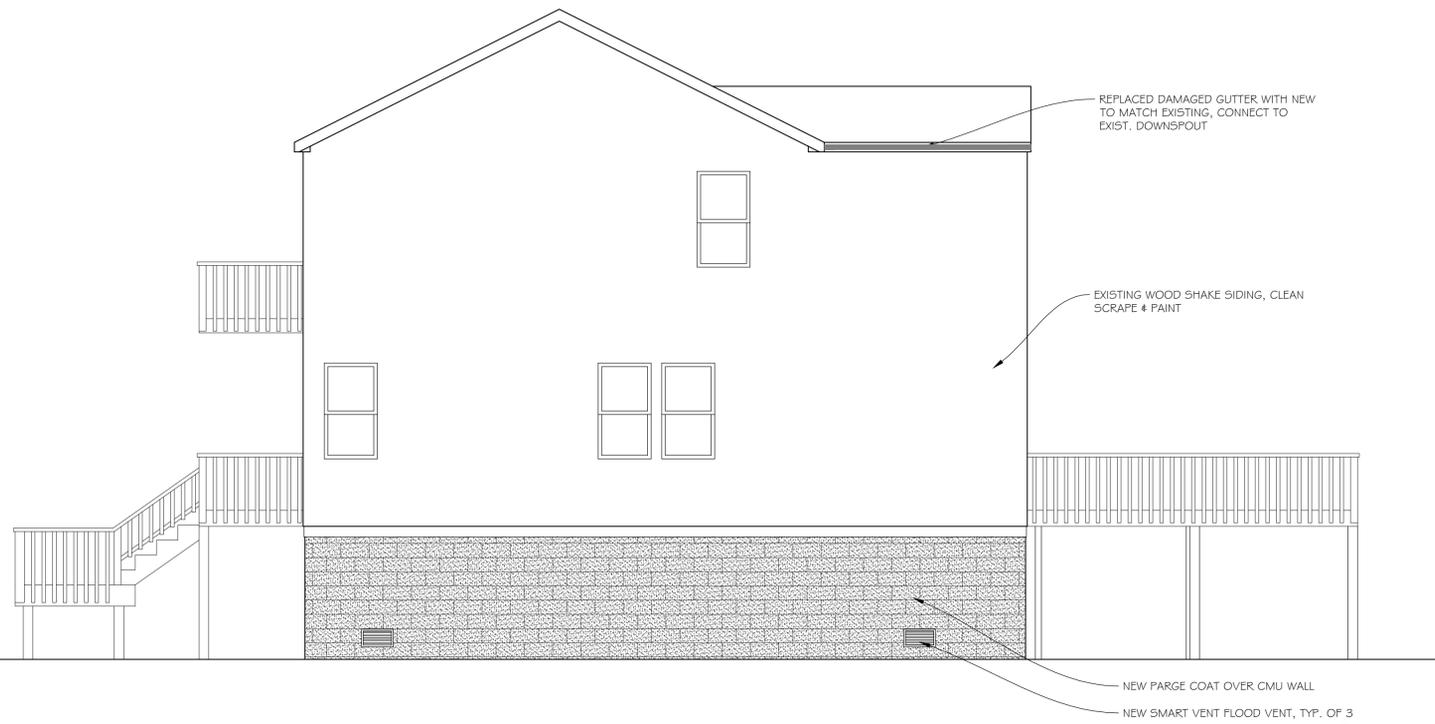

**RIGHT SIDE ELEVATION**

SCALE: 1/4" = 1'-0"

4



**REAR ELEVATION**

SCALE: 1/4" = 1'-0"


2



**LEFT SIDE ELEVATION**

SCALE: 1/4" = 1'-0"

3

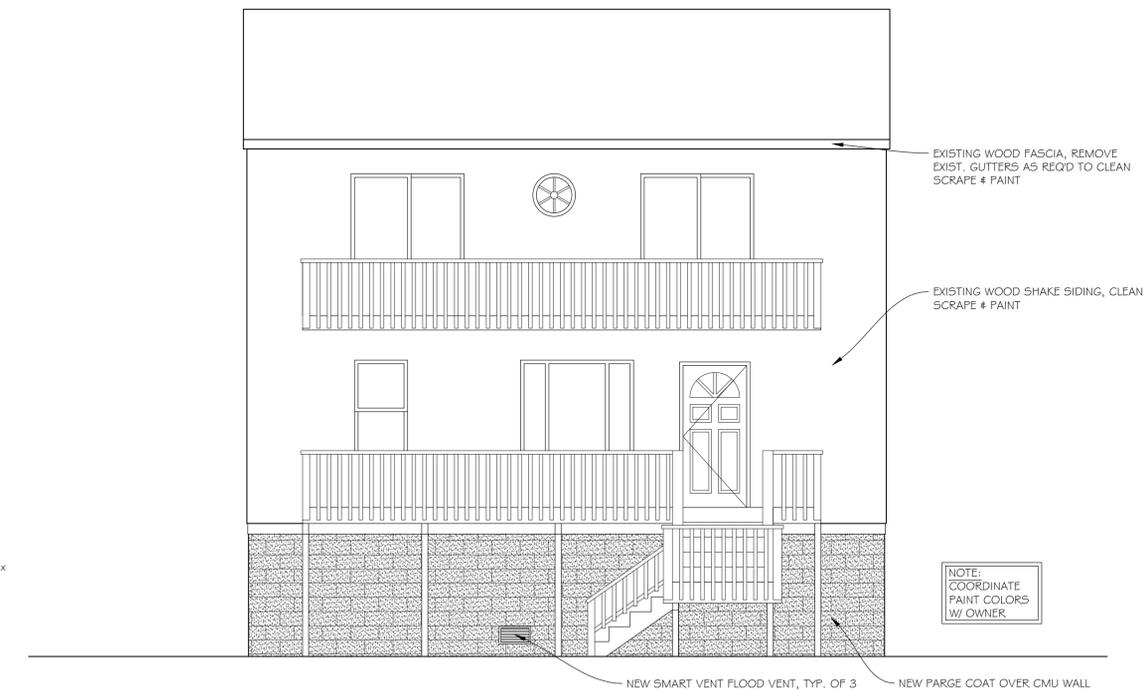

**FRONT ELEVATION**

SCALE: 1/4" = 1'-0"

1